




01 WEST ELEVATION/ BLDG A
1/8" = 1'-0"

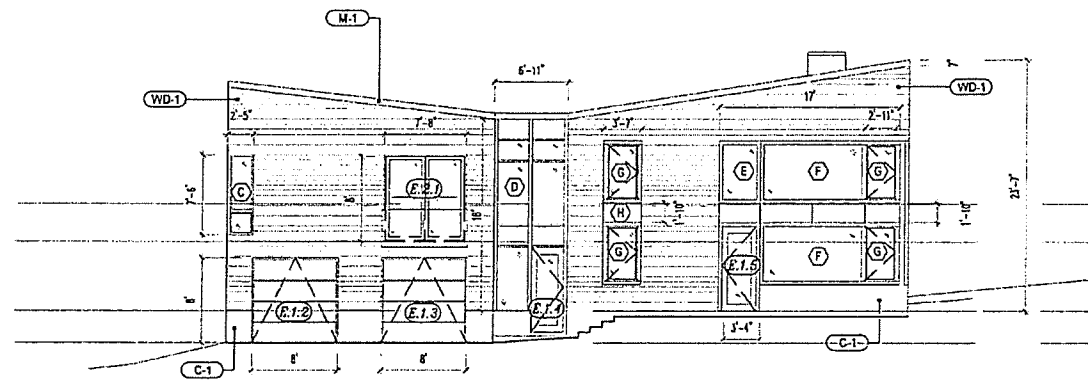


02 SOUTH ELEVATION
1/8" = 1'-0"

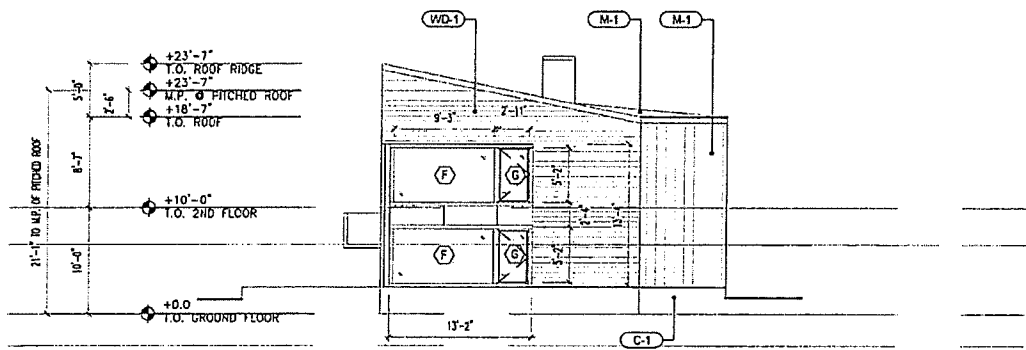

03 EAST ELEVATION BLDG B
1/8" = 1'-0"

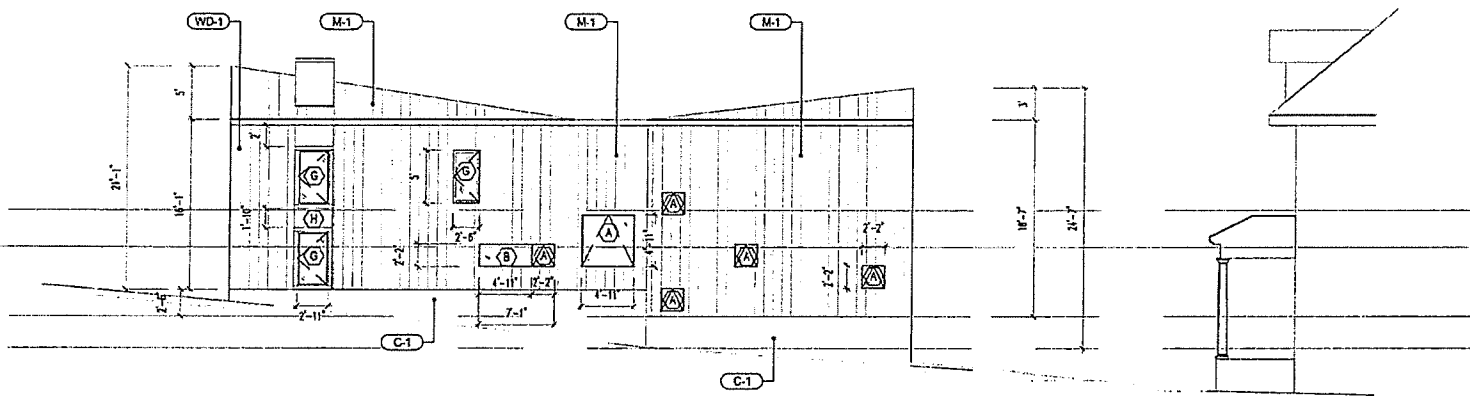

04 NORTH ELEVATION
1/8" = 1'-0"

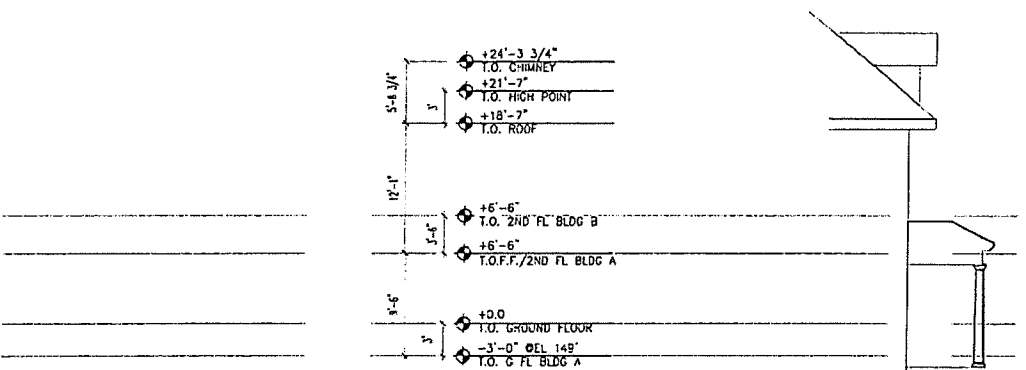

05 E-W SECTION
1/8" = 1'-0"

EXTERIOR FINISH LEGEND	
WALL	
M-1	FORMED METAL WALL PANELS/WESTERN RIB BY WESTERN STATES METAL ROOFING
WD-1	MILL GRADE, PTD. CEDAR, CLAPBOARD 1X8 WD SIDING
C-1	WATER SEALED CONCRETE RETAINING WALL
ROOF	
M-1	FORMED METAL ROOFING / WESTERN RIB BY WESTERN STATES METAL ROOFING
TAG LEGEND	
(E.1.0)	EXTERIOR DOOR NUMBER SEE SCHEDULE A-501
(X)	WINDOW TYPE NUMBER SEE SCHEDULE A-500
(XX-0)	EXTERIOR FINISH

Project
FELLOWS RESIDENCE
GARAGE REPLACEMENT & GUESTHOUSE

362 S UNION STREET
BURLINGTON, VT 05401

Architect

WFA


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Civil Engineer

Mechanical / Electrical / Plumbing Engineer

Structural Engineer

PREMISES: 362 S UNION ST, BURLINGTON, VT
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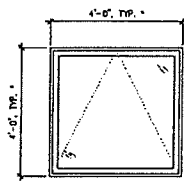
Scale

Revision	Date	Remarks

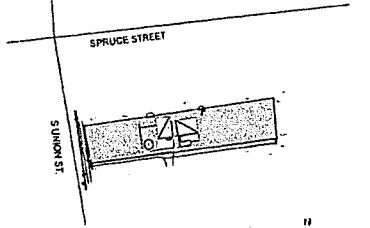BUILDING ELEVATIONS & SECTIONS


Project No. 20-002	Drawing No. A-201.00
Date 06/15/2020	
Scale AS NOTED	
Drawn / Checked TS	

WINDOW TYPES




WINDOW TYPE (A)
AWNING

* ATYPICAL SIZES:
(1) 4'-0" N.O. (W) X 4'-0" N.O. (H);
SEE 01/A201
(1) 4'-11" N.O. (W) X 4'-11" N.O. (H);
SEE 04/A201
(5) 2'-2" N.O. (W) X 2'-2" N.O. (H);
SEE 04/A201

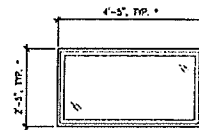


WINDOW TYPE (B)
CASEMENT


* ATYPICAL SIZES:
(4) 4'-5" N.O. (W) X 2'-5" N.O. (H);
SEE 01/A201
(1) 4'-11" N.O. (W) X 2'-2" N.O. (H);
SEE 04/A201

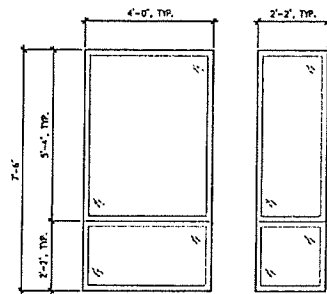


WINDOW TYPE (C)
FIXED W/ MULLION/CORNER

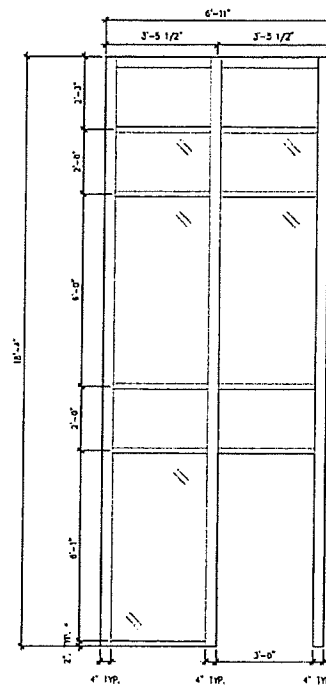


WINDOW TYPE (D)
FIXED FRAME DIRECT SET

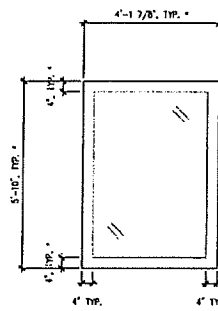

WINDOW TYPE (E)
FIXED FRAME DIRECT SET
(1) FIXED

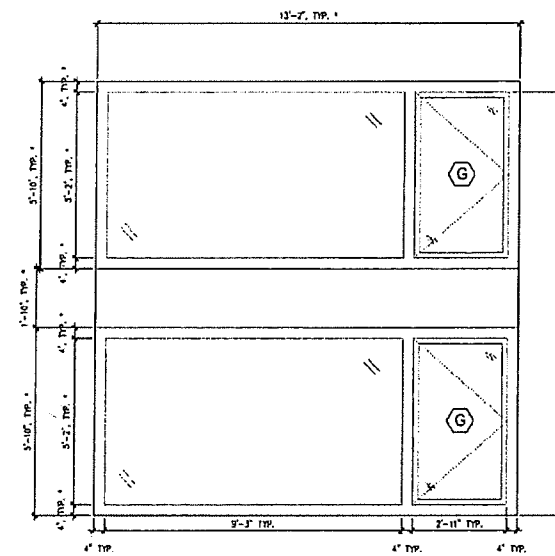


WINDOW TYPE (F)
FIXED FRAME DIRECT SET X (2)
(SEE TYPE G FOR OPERABLE CASEMENT)

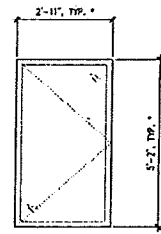

WINDOW TYPE (G)
CASEMENT (1) OPERABLE

* ATYPICAL SIZES:
(1) 2'-11" N.O. (W) X 5'-2" N.O. (H);
SEE 02/A201
(1) 2'-6" N.O. (W) X 5'-0" N.O. (H);
SEE 04/A201

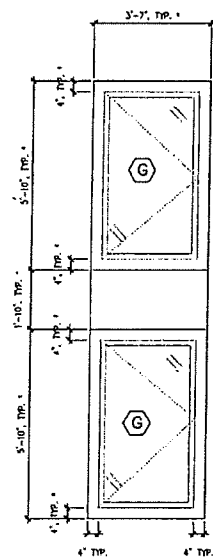

WINDOW TYPE (H)
FIXED FRAME DIRECT SET
(2) OPERABLE (SEE TYPE G)

WINDOW TYPE SCHEDULE

TYPE	MATERIAL	FINISH		WINDOW DETAILS				GLAZING	PERFORMANCE REQUIREMENTS
		EXTERIOR	INTERIOR	HEAD	JAMB	SILL	MULLION		
A	PTD WD/ PTD ALUM	PTD ALUM CLAD	PTD WD/ PTD ALUM					INSULATED LOW E GLAZING - (1-5/16") THICK INSULATED UNIT WITH A 3/8" AIR SPACE	U VALUE ≤ .27
B	PTD WD/ PTD ALUM	PTD ALUM CLAD	PTD WD/ PTD ALUM						
C	PTD WD/ PTD ALUM	PTD ALUM CLAD	PTD WD/ PTD ALUM						
D	PTD WD/ PTD ALUM	PTD ALUM CLAD	PTD WD/ PTD ALUM						
E	PTD WD/ PTD ALUM	PTD ALUM CLAD	PTD WD/ PTD ALUM						
F	PTD WD/ PTD ALUM	PTD ALUM CLAD	PTD WD/ PTD ALUM						
G	PTD WD/ PTD ALUM	PTD ALUM CLAD	PTD WD/ PTD ALUM						

WINDOW NOTES:

- ALL MASONRY OPENING DIMENSIONS SHALL BE VERIFIED IN FIELD (V.I.F.) AND REFLECTED IN THE REQUIRED SHOP DRAWINGS.
- CONTRACTOR TO COORDINATE AND SUPPLY ALL NECESSARY ACCESSORIES, TEMPLATES, AND/OR DEVICES TO COMPLETE THE INTENDED WINDOW SPECIFIED.
- ALL WORK IS TO CONFORM TO ALL APPLICABLE REQUIREMENTS OF LOCAL GOVERNING CODES, HEALTH CODE, FIRE DEPARTMENT REGULATIONS, NBFJ AND UTILITY CODES, OSHA CODES AND NEW YORK CITY BUILDING CODE.

Project

FELLOWS RESIDENCE
GARAGE REPLACEMENT & GUESTHOUSE

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Architect

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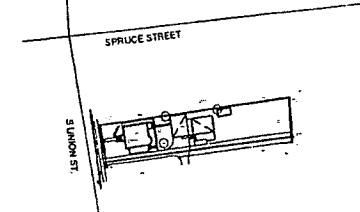
352 S UNION STREET
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Seal


Revision Date Remarks

EXTERIOR WINDOW SCHEDULE


Project No. 20-002
Date 06/15/2020
Scale NA
Drawn / Checked TS

Drawing No. A-501.00


EXTERIOR DOOR TYPES

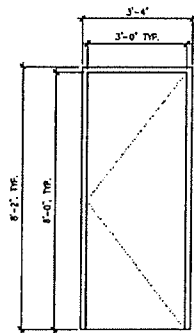


EXT. DOOR TYPE "A"
ENTRY DOOR W/ FLAT H.M. PTD

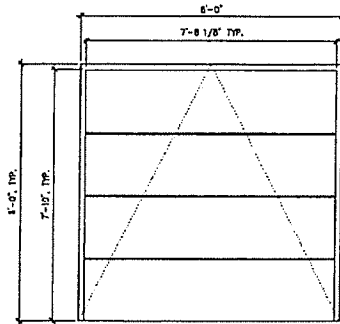


EXT. DOOR TYPE "B"
GARAGE DOOR

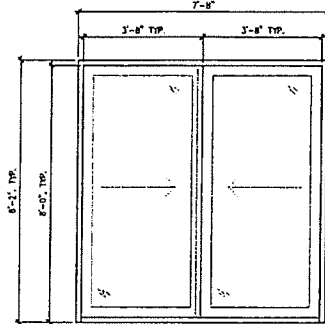

EXT. DOOR TYPE "C"
PATIO IN-SWING DOUBLE DOOR

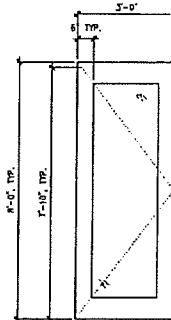

EXT. DOOR TYPE "D"
ENTRY OUT-SWING DOOR
W/ FIXED GLAZING

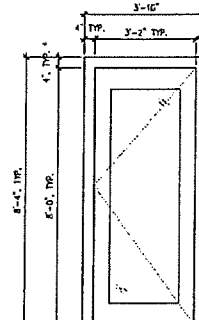

EXT. DOOR TYPE "E"
PATIO OUT-SWING DOOR
W/ FIXED GLAZING

Project

FELLOWS RESIDENCE
GARAGE REPLACEMENT & GUESTHOUSE

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BURLINGTON, VT 05401

Architect

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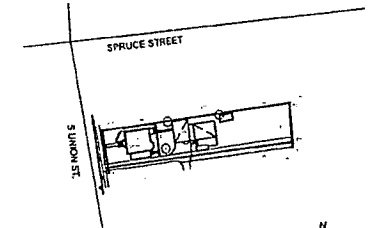
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Seal

Revision	Date	Remarks

EXTERIOR DOOR SCHEDULE

Project No. 20-002	Drawing No. A-502.00
Date 06/15/2020	
Scale NA	
Drawn / Checked TS	

EXTERIOR DOOR SCHEDULE

DOOR NO.	DOOR TYPE	OVERALL DIMENSION: W x H x D (JAMB)	DOOR MATERIAL	FRAME MATERIAL	GLAZING	PERFORMANCE REQUIREMENTS
E.1.1	A	3'-4" x 8'-2"	PTD HM	PTD HM	N/A	N/A
E.1.2	B	8'-0" x 8'-0"	PTD ALUM/OR FIBERGLASS	PTD HM	N/A	N/A
E.1.3	B	8'-0" x 8'-0"				
E.1.4	D	3'-0" x 8'-0"	PTD ALUM W/ GLAZING	PTD WD/ PTD ALUM FIXED FRAME DIRECT SET SEE WINDOW SCHED. TYPE D	HIGH IMPACT INSULATED LOW E GLAZING - (1-5/16") THICK INSULATED UNIT WITH A 3/8" AIR SPACE	U VALUE ≤ .27
E.1.5	E	3'-10" x 8'-4"				
E.2.1	C	7'-8" x 8'-2"	PTD ALUM W/GLAZING	PTD HM	INSULATED LOW E GLAZING - (1-5/16") THICK INSULATED UNIT WITH A 3/8" AIR SPACE	

FELLOWS RESIDENCE
GARAGE REPLACEMENT & GUESTHOUSE

352 S UNION STREET
BURLINGTON, VT 05401

Address

WFA


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Seal

GENERAL CONSTRUCTION NOTES

GENERAL REQUIREMENTS

- 1. ALL WORK SHALL BE DONE IN ACCORDANCE WITH THE OFFICIAL COMPILATION OF CODES, RULES AND REGULATIONS OF THE STATE OF VERMONT...
2. ALL CONSTRUCTION WILL COMPLY WITH THE REQUIREMENTS OF THE BURLINGTON CITY BUILDING CODES...
3. CONTRACTOR SHALL COMPLY WITH ALL THE RULES AND REGULATIONS AS SET FORTH BY THE AGREEMENT BETWEEN THE BUILDING OWNER AND TENANT...
4. THE GENERAL CONTRACTOR DOING THE WORK SHALL OBTAIN NECESSARY PERMITS AND APPROVALS PRIOR TO PROCEEDING WITH CONSTRUCTION...
5. UNTIL SUCH TIME AS AN AMENDED CERTIFICATE OF OCCUPANCY HAS BEEN ISSUED...
6. ALL WORK SHALL CONFORM TO THE APPROVED APPLICATION AND ANY APPROVED AMENDMENTS THEREIN...
7. THERE ARE NO WARRANTIES MADE BY PKSB ARCHITECTS...
8. THE PLANS AND OTHER INFORMATION PROVIDED BY PKSB ARCHITECTS...
DEMOLITION NOTES
1. ALL WORK TO BE DONE IN ACCORDANCE WITH THE OFFICIAL COMPILATION OF CODES, RULES AND REGULATIONS OF THE STATE OF VERMONT...
2. WORK TO BE PERFORMED IN ACCORDANCE WITH THE PROVISIONS OF GENERAL CONDITIONS FOR CONSTRUCTION...
3. DEMOLITION CONTRACTOR SHALL AT ALL TIMES MAINTAIN THE STRUCTURAL INTEGRITY OF THE ENTIRE BUILDING AND PREMISES...
4. CONTRACTOR SHALL CONFIRM BEFORE REMOVING ANY INTERIOR PARTITIONS THAT SUCH PARTITIONS ARE EXISTING NON-LOAD BEARING PARTITIONS...
5. THE CONTRACTOR SHALL VERIFY ALL DIMENSIONS AND CONDITIONS AT THE SITE DURING THE ESTIMATING STAGE...
6. APPROVED PLANS AND ALL OTHER NECESSARY PERMITS SHALL BE AT THE SITE AT ALL TIMES DURING THE PERFORMANCE OF THE WORK UNDER THIS CONTRACT...
7. ALL WORK SHALL BE PERFORMED IN THE NORMAL ACCEPTABLE MANNER...
8. CONTRACTOR SHALL FURNISH ALL NAILS, SPIRES, BOLTS, SCREWS, HANGERS, ANCHORS, THE RISERS AND FURISH CHUTES AND OTHER ACCESSORIES ON THE DRAWINGS OR AS MAY BE REQUIRED TO PROPERLY COMPLETE THE DEMOLITION WORK...
9. ALL UNBORN AND CONCRETE REQUIRED TO BE USED IN THE COMPLETION OF THE DEMOLITION WORK SHALL BE IN FULL ACCORD WITH THE BUILDING CODE OF THE CITY OF NEW YORK...
10. COMPLIANCE WITH THE REQUIREMENTS OF AGENCIES HAVING JURISDICTION OVER REMOVAL OF DEBRIS SHALL BE THE RESPONSIBILITY OF THE CONTRACTOR IN ACCORDANCE WITH THE GENERAL CONTRACT AGREEMENT...
11. ANY DEMOLITION REQUIRING ROUGH FRAMING SHALL BE DONE AFTER THE BASIC DEMOLITION AND IN CONJUNCTION WITH AN INSPECTOR BY THE ARCHITECT...
12. DISCONNECT AND REMOVE ANY SURFACE MOUNTED OR BURIED CONDUIT INCLUDING SWITCHES OR OUTLETS ON PARTITIONS TO BE REMOVED...
13. REMOVE ALL TELEPHONE ELECTRICAL DISTRIBUTION WIRES, CONDUITS, PANELS, RECEPTACLES, OUTLETS AND OTHER ELECTRICAL EQUIPMENT NOT INTENDED TO BE USED...
14. REMOVE EXISTING LIGHT FIXTURES AND DISCONNECT CIRCUITS AS INDICATED ON ELECTRICAL DRAWING COORDINATE WITH MEP DRAWINGS...
15. REMAINING WALLS TO BE PREPARED FOR ROUGHING OF TRADES AS INDICATED ON DRAWINGS INCLUDING THE FINISH SCHEDULE...
16. THE CONTRACTOR SHALL PROVIDE AND GUARANTEE FOR ONE YEAR, ROBBENT OR CHEATING INSECT CONTROL, TREATING THE ENTIRE PREMISES BEFORE ANY WORK COMMENCES...
17. REMAINING WALLS TO BE PREPARED FOR ROUGHING OF TRADES AS INDICATED ON DRAWINGS INCLUDING THE FINISH SCHEDULE...
18. THE CONTRACTOR SHALL PROVIDE AND GUARANTEE FOR ONE YEAR, ROBBENT OR CHEATING INSECT CONTROL, TREATING THE ENTIRE PREMISES BEFORE ANY WORK COMMENCES...
19. REMAINING WALLS TO BE PREPARED FOR ROUGHING OF TRADES AS INDICATED ON DRAWINGS INCLUDING THE FINISH SCHEDULE...
20. COMPLIANCE WITH REQUIREMENTS OF AGENCIES HAVING JURISDICTION OVER THE REMOVAL OF DEBRIS SHALL BE THE RESPONSIBILITY OF THE CONTRACTOR.

QUALITY ASSURANCES

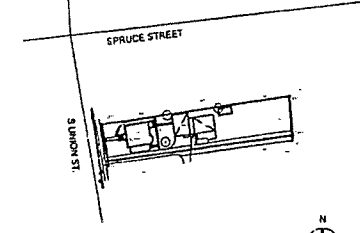- 1. THE CONTRACTOR SHALL BE RESPONSIBLE FOR HIS WORK, ANY DISCREPANCIES IN THE DRAWINGS SHALL BE IMMEDIATELY CALLED TO THE ATTENTION OF THE ARCHITECT.
2. IT IS THE RESPONSIBILITY OF THE CONTRACTOR TO EXAMINE ALL DRAWINGS AND DATES AND COORDINATE THE WORK OF EACH SPECIFICATION SECTION WITH ALL RELATED AND ADJOINING WORK.
3. CONTRACTOR SHALL PERFORM HIS SERVICES UNDER THIS CONTRACT IN A SKILLFUL AND COMPETENT MANNER IN ACCORDANCE WITH THE HIGHEST STANDARDS OF THE CONSTRUCTION INDUSTRY.
4. ALL WORK IS TO BE DONE TO THE BEST STANDARDS OF EACH TRADE. APPLICABLE INSTITUTE OR ASSOCIATIONS STANDARDS SHALL APPLY.
5. THE CONTRACTOR SHALL VISIT THE SITE AND SHALL VERIFY BY INSPECTION ALL EXISTING CONDITIONS AS THESE CONDITIONS MIGHT AFFECT THE SCOPE OF THE WORK CONTEMPLATED BY THESE DRAWINGS, INCLUDING ACCESS TO THE SITE, THE NATURE OF STRUCTURES, OBJECTS AND MATERIALS TO BE ENCOUNTERED IN THIS WORK AND INFORMATION ON THE DRAWINGS SHOWING EXISTING CONDITIONS DOES NOT CONSTITUTE A GUARANTEE THAT OTHER ITEMS MAY NOT BE FOUND, AND CONTRACTOR MUST USE HIS BEST EFFORTS TO VERIFY ALL CONDITIONS, BY ENTERING INTO THIS CONTRACT CONTRACTOR ASSUMES ALL CONDITIONS, UNLESS NOTED OTHERWISE BY THE CONTRACTOR THAT WILL AFFECT THE SCOPE OF THE WORK.

WORK INCLUDED

- 1. PROVIDE ALL LABOR, MATERIALS, EQUIPMENT, SERVICES, ETC., NECESSARY OR REQUIRED FOR THE WORK OF THIS CONTRACT, AS INDICATED ON THE DRAWINGS, HEREIN SPECIFIED AND AS REQUIRED BY THE EXISTING CONDITIONS FOR PROPER PERFORMANCE AND COMPLETION, AND IN ACCORDANCE WITH THE REQUIREMENTS OF THE CONTRACT DOCUMENTS.
2. THE WORK OF THIS CONTRACT SHALL, IN GENERAL, INCLUDE EACH AND EVERY TRADE AND/OR SUB-CONTRACT COVERED BY THE VARIOUS SECTIONS OF THE SPECIFICATIONS UNDER THIS CONTRACT, AND MAY ALSO INCLUDE WORK OF OTHER TRADES NOT SPECIFIED UNDER SUCH OTHER SECTIONS AS NEEDED TO CARRY OUT THE WORK OF THIS CONTRACT TO COMPLETION.
3. UNLESS OTHERWISE REQUIRED BY THE DRAWINGS OR SPECIFIED THEREIN, ALL MATERIALS AND WORKMANSHIP FOR THE WORK OF ALTERATIONS SHALL CONFORM TO APPLICABLE REQUIREMENTS OF THE VARIOUS OTHER SECTIONS OF THE SPECIFICATIONS UNDER THIS CONTRACT.
4. IT IS THE INTENT OF THIS SECTION TO OBTAIN A COMPLETE FINISHED INSTALLATION IN SO FAR AS ALTERATION TO THE EXISTING BUILDING IS CONCERNED.
5. GENERAL CONTRACTOR IS TO SEE THAT ALL TRADES COOPERATE TOGETHER TO SATISFY THE PROPER COMPLETION OF WORK OF EACH OF THE TRADES, ADVISE THEM OF CONDITIONS NECESSARY FOR PROPER INSTALLATION OF EACH TRADE AND ADMINISTER THROUGHOUT THE CONSTRUCTION PERIOD THE REQUIRED COORDINATION.
6. WORKERS SHALL BE ALLOWED ONLY IN THOSE PARTS OF THE EXISTING SPACE WHERE WORK OF THIS CONTRACT IS IN PROGRESS AND ONLY AT SUCH TIMES AS ACTUAL WORK IS BEING DONE. IT SHALL BE THE RESPONSIBILITY OF THE CONTRACTOR TO CONTROL AND DENY ACCESS TO EXISTING SPACE AT ALL TIMES.
7. THE WORK SHALL BE DONE IN SUCH A MANNER THAT CAUSE AS LITTLE INTERFERENCE WITH FUNCTIONING OF THE VARIOUS SUB-CONTRACTORS WITHOUT ANNOYANCE OR DANGER TO EMPLOYEES, AND THE PUBLIC AND WITH A MINIMUM OF NOISE.
8. CONTRACTOR SHALL PROVIDE PROPER CLEANUP OF ALL WORK BEFORE FINAL PAYMENT. THIS INCLUDES FINISHES.

PRODUCTS

- 1. ALL NEW WORK, MATERIALS ASSEMBLIES, METHODS OF CONSTRUCTION, SERVICES EQUIPMENT SHALL COMPLY WITH ALL RULES AND REGULATIONS OF THE DEPARTMENT OF BUILDINGS AND WITH ALL OTHER AGENCIES HAVING JURISDICTION, IN THE CITY OF NEW YORK.
2. ALL MATERIAL AND EQUIPMENT SUPPLIED BY THE CONTRACTOR SHALL HAVE ASTM RATING AND ALL LABEL APPROVAL NUMBER FOR USE IN THE STATE OF NEW YORK AND THE CITY OF NEW YORK.
3. ALL EQUIPMENT SUPPLIED BY THE CONTRACTOR SHALL HAVE A BSA OR IEA APPROVAL NUMBER AS REQUIRED FOR USE IN THE STATE OF NEW YORK.
4. THE CONTRACTOR SHALL PROVIDE ALL NECESSARY SUPPORTS, BRACING, SHORING, ETC., OF BOTH EXISTING AND NEW CONSTRUCTION, AND THE COMPLETE PROTECTION OF PUBLIC, WORKERS AND PROPERTY.
5. THE CONTRACTOR SHALL PROVIDE ALL NECESSARY SCAFFOLDING, TEMPORARY DUST PARTITIONS, WALLS, SCREENS, FENCES, LADDERS, RAILS, WINDOW PROTECTIONS ETC., AS REQUIRED.
6. MATERIALS ARE TO BE STORED ONLY AT LOCATIONS DESIGNATED BY THE ARCHITECT.
7. ALL MATERIALS, ASSEMBLIES AND PRODUCTS BROUGHT ON SITE ARE TO BE PROPERLY PROTECTED FROM DAMAGE. CONTRACTOR IS FULLY RESPONSIBLE FOR ANY DAMAGE AND / OR VANDALISM TO DELIVERED ITEMS.

RELATED WORK

- 1. ALL DEMOLITION AND/OR REMOVAL OF EXISTING WORK, CUTTING AND PATCHING, AND ALL INCIDENTAL WORK IN CONNECTION THEREWITH SO THAT ALTERATIONS CAN BE MADE AND NEW WORK INSTALLED.
2. ALL DEMOLITION AND REMOVAL WORK SHALL BE PERFORMED IN THE BEST WORKMANLIKE MANNER AND IN ACCORDANCE WITH THOSE PRACTICES NORMAL TO AND ACCEPTABLE IN THE TRADE. IN ALL CASES, EXTREME PRECAUTIONS SHALL BE TAKEN TO INSURE THE SAFETY TO PROPERTY AND PERSONS. NO ACCUMULATIVE DEBRIS ALLOWED.
3. ANY AREA TO REMAIN REQUIRING DEMOLITION FOR THE INSTALLATION OF WORK SHALL BE RESTORED BY THE CONTRACTOR TO ITS ORIGINAL FINISHED CONDITION OR AS OTHERWISE CALLED FOR IN THE CONTRACT DOCUMENTS.
4. COMPLIANCE WITH REQUIREMENTS OF AGENCIES HAVING JURISDICTION OVER THE REMOVAL OF DEBRIS SHALL BE THE RESPONSIBILITY OF THE CONTRACTOR.

JOB CONDITIONS

- 1. CONTRACTOR SHALL CHECK AND VERIFY ALL DIMENSIONS AND CONDITIONS AT THE PROJECT SITE AND BE RESPONSIBLE FOR SAME. IN CASES OF DISCREPANCY, CONFLICT OR DOUBT, CONTRACTOR SHALL NOTIFY THE ARCHITECT IN SUFFICIENT TIME TO CLARIFY AND RESOLVE THE PROBLEM PRIOR TO THE CONTRACTOR PROCEEDING WITH THE WORK.
2. CONTRACTOR SHALL NOT SCALE THE DRAWINGS FOR THE EXECUTION OF WORK. CONTRACTOR TO VERIFY THE EXISTING CONDITIONS AND CROSS CHECK ALL DOCUMENTS FOR A COMPLETE SCOPE OF WORK. ALL DIMENSIONS NECESSARY FOR WORK SHALL BE VERIFIED BY FIELD MEASUREMENTS BEFORE COMMENCEMENT OF WORK BY THE CONTRACTOR. THE CONTRACTOR IS RESPONSIBLE FOR A CORRECT FIT OF ALL WORK TO PREEXISTING CONDITIONS.
3. CONTRACTOR SHALL EXAMINE THE SITE AND CHECK EXISTING CONDITIONS TO THE FULL EXTENT OF THE SCOPE OF WORK. HE SHALL COORDINATE WORK WITH ALL TRADES AND OTHER CONTRACTORS RETAINED BY THE OWNER. THE ARCHITECT SHALL BE NOTIFIED OF ANY DISCREPANCIES OR CONFLICTS PRIOR TO THE EXECUTION OF ANY WORK.
4. AREAS OF WORK OF THE CONTRACT SHALL BE ACCEPTED AS FOUND AT THE START OF THE WORK.
5. PREPARATION OF EXISTING SURFACES AND WORK AS REQUIRED FOR THE NEW CONSTRUCTION AND FINISHES.
6. THE CONTRACTOR IS RESPONSIBLE FOR DETERMINING THE SAFE AND LEGAL LOADS FOR ALL FLOOR CONSTRUCTION, THE CONTRACTOR SHALL NOT LOAD NOR PERMIT THE FLOORS TO BE LOADED WITH MATERIALS OR DEBRIS IN EXCESS OF THE ALLOWABLE LOAD LIMITS.
7. EVERY PRECAUTION SHALL BE TAKEN BY THE CONTRACTOR TO INSURE THE SAFETY OF LIFE AND ALL PERSONNEL WORKING ON OR VISITING THE SITE.
8. THE CONTRACTOR SHALL BE RESPONSIBLE FOR ALL CUTTING, PATCHING, ALTERING AND ADDING TO EXISTING CONSTRUCTION AND FINISHES AS REQUIRED TO LEAVE SUCH CONSTRUCTION AND FINISHES COMPLETE AND IN A CONDITION SATISFACTORY TO THE ARCHITECT. FURTHER THE CONTRACTOR SHALL EXTEND, PATCH AND ADD EXISTING CONSTRUCTION AND FINISHES LEFT INCOMPLETE BY REASON OF THE WORK OF THIS CONTRACT, AND TO REMOVE EXISTING CONSTRUCTION FINISHES NO LONGER REQUIRED, WHETHER OR NOT PARTICULARLY INDICATED ON THE DRAWINGS OR SPECIFIED.

SUBMITTALS


- 1. THE CONTRACTOR SHALL SUBMIT SHOP DRAWINGS, FOR, BUT NOT LIMITED TO, HVAC, ELECTRICAL, PLUMBING, CABINET, MILLWORK, STONE FABRICATION ITEMS FOR APPROVAL BY THE ARCHITECT PRIOR TO PURCHASE, FABRICATION OR CONSTRUCTION.
2. THE CONTRACTOR SHALL SUBMIT FOR INSPECTION AND APPROVAL OF DESIGN BY ARCHITECT, MANUFACTURER'S SAMPLES AND OR CUTS OF ANY AND ALL ITEMS TO BE INSTALLED IN THIS PROJECT INCLUDING BUT NOT LIMITED TO LIGHT FIXTURES, ELECTRICAL DEVICES, CEILING DIFFUSERS, HARDWARE, FINISH SAMPLES, WOOD, STONE, ETC.
3. ALL WORK SHALL BE MANUFACTURED IN AMPLE TIME SO NOT TO DELAY THE PROGRESS OF THE WORK AND SHALL BE DELIVERED AT SUCH TIME REQUIRED FOR PROPER COORDINATION OF WORK. PRIOR TO COMMENCING WORK, CONTRACTOR SHALL SUBMIT A SCHEDULE OF WORK PROGRESS FOR APPROVAL BY ANY AGENCIES HAVING JURISDICTION.

ENERGY CONSERVATION CONSTRUCTION
VERMONT RESIDENTIAL BUILDING ENERGY CODE (2019)


Table with 3 columns: Item description, Item description, Proposed Design Value. Includes entries for ENVELOPE (FLOOR, WALL, CEILING, NON WINDOWS), HEATING AND COOLING (BASE), WATER (BASE), and ELECTRICALS (LOADING).

COMPLIANCE STATEMENT: TO THE BEST OF MY KNOWLEDGE, BELIEF AND PROFESSIONAL JUDGMENT, THIS APPLICATION IS IN COMPLIANCE WITH THE ENERGY CONSERVATION CONSTRUCTION CODE OF VERMONT RESIDENTIAL BUILDING ENERGY CODE (2019)

CONSTRUCTION LEGEND

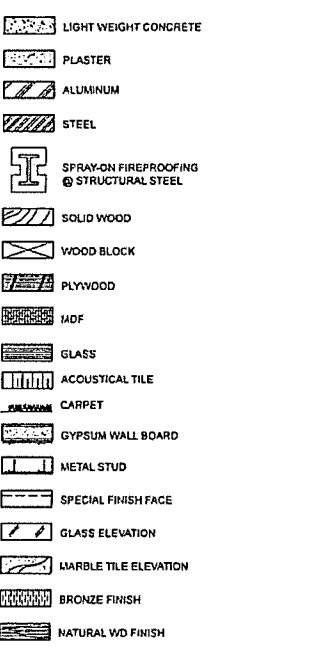


DRAWING SYMBOLS

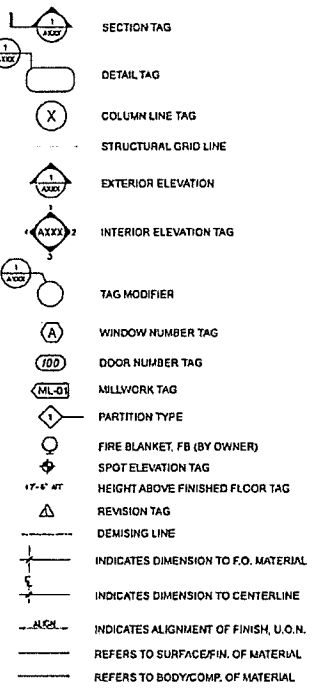

ABBREVIATIONS

Table with 2 columns: Abbreviation and Full Name. Includes AFF ABOVE FINISHED FLOOR, ALUM ALUMINUM, BO BY OWNER, CAB CABINET, CLG CEILING, DR DOOR, EQ EQUAL, EXISTG EXISTING, FB FIRE BLANKET, FE FIRE EXTINGUISHER, FIN FINISH, HM HOLLOW METAL, ML MILLWORK, MTD MOUNTED, MTL METAL, P-LAM PLASTIC LAMINATE, PTD PAINTED, SCHED SCHEDULED, STL STEEL, THK THICK, TYP TYPICAL, U.O.N. UNLESS OTHERWISE NOTED, VF VERIFY IN FIELD, WD WOOD.

ELECTRICAL OUTLET AND TYPICAL DEVICE MOUNTING HEIGHTS

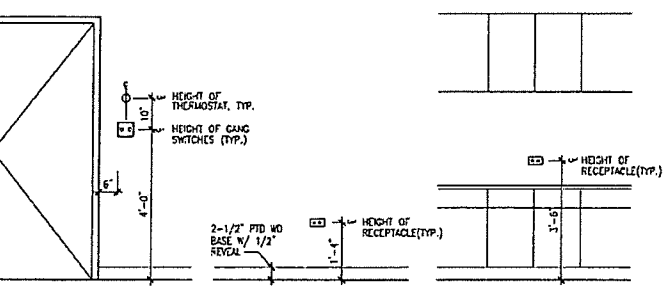

GENERAL NOTES
LEGENDS & CODES

Table with 2 columns: Project No. and Drawing No. Project No. includes 20-002, Date 06/15/2020, Scale NA, Drawn / Checked TS / WLF. Drawing No. includes T-001.00.